



CITY OF ELIZABETHTON

Building Department Erosion and Sedimentation Control Permit Application For a Single Residential Lot

Please contact the Inspection Office (423-542-1503) with any questions.

Building Permit Applicant

Name: _____
Street Address: _____
Phone: _____

Person responsible for Erosion and Sediment Control for the duration of the project.

Certification #: _____
Name: _____
Address: _____

Cell Phone: _____
Fax: _____

Building Site Address

Street Address: _____

For Office Use Only – Do Not Fill Out

Building Permit #: _____

E.C. Permit #: _____

Standard Fee: Single Residential Lot - \$50.00

Plans Approved: Yes No Date: _____

Permit Issued By: _____

Reason for Denial: _____

Information to be included on site plan:

- | | |
|----------------------------------|---|
| 1. Scale – 1"=50' | 6. Location of all (silt fences) |
| 2. Property lines | 7. Location of nearest downstream catch basin |
| 3. Contour lines or slope arrows | 8. Location of project information sign |
| 4. Location of all structures | 9. Sheet size – 8 ½" x 11" minimum |
| 5. Location of hard surfaces | |

Describe proposed erosion control facilities (Show locations of erosion control facilities on site plan – include details with plan):

Describe mulching and revegetation plan (Show limits of mulching and revegetation on site plan):

Describe method of protection of nearest downstream catch basin:

NOTICE

Materials tracked into streets shall be cleaned prior to the close of each workday by means of dry sweeping (e.g. with a broom and shovel). Materials shall **not** be washed down the road into the storm sewer or water bodies.

The following will result in an enforcement action by the City:

1. Visible or measurable erosion resulting in off-site sediment transport.
2. Failure to maintain the project information and address signs in a readable condition.
3. Failure to maintain protective devices located at catch basins throughout the duration of the project.
4. Failure to maintain silt fence or other erosion control facilities.

CONSENT STATEMENT

I authorize a representative of the CITY OF ELIZABETHTON to enter upon the permitted property for the purpose of making inspection.


Signature of Authorized Agent or Owner

_____/_____/_____
Date



Example of Residential Site Plan

Legend	
Flow Lines	
Silt Fence	
Swale	
Property Corner	
Undisturbed Area	

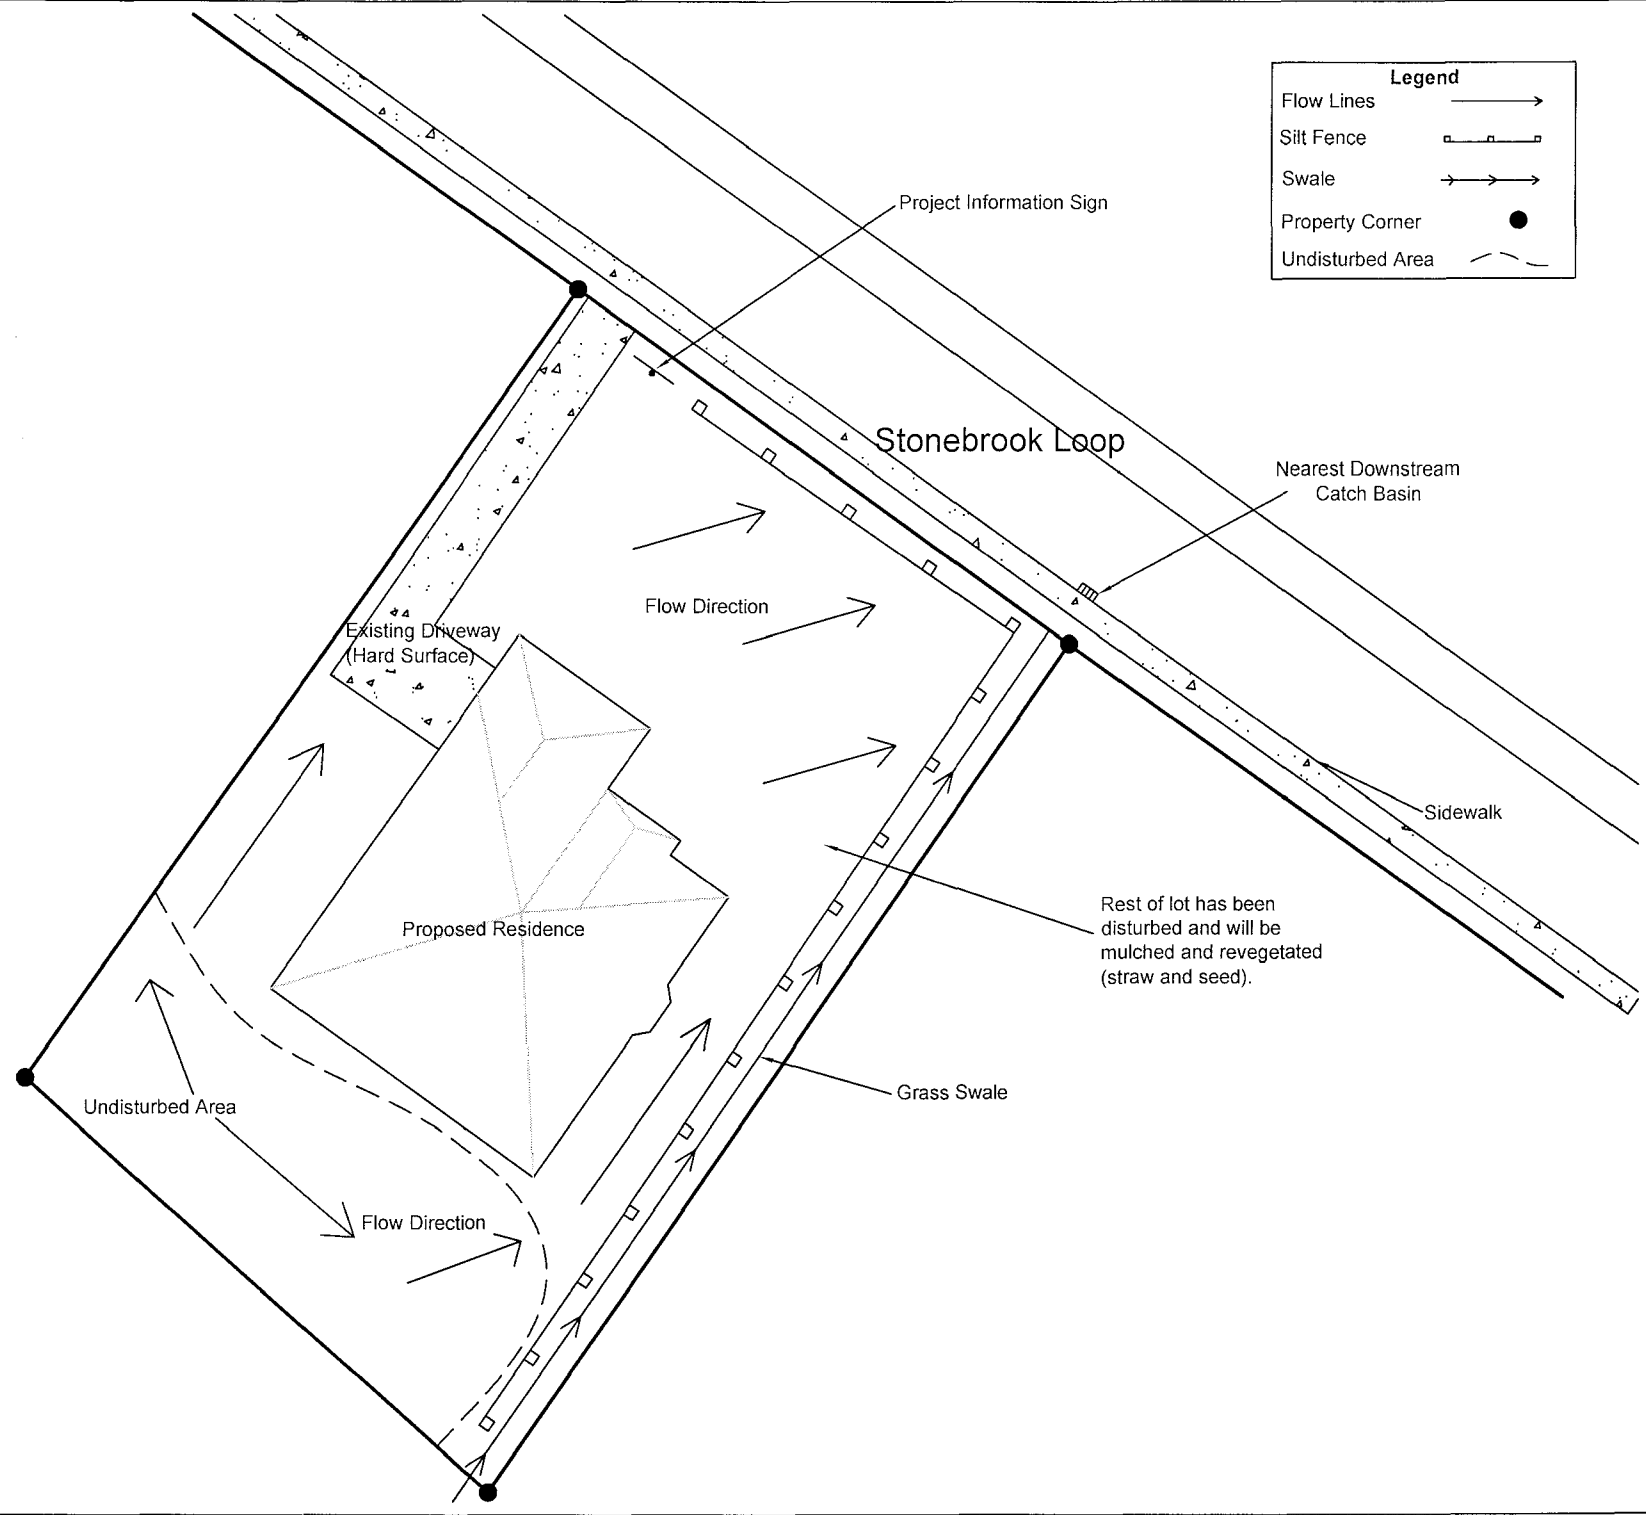


BY	DATE	DESCRIPTION

PROJECT: Example of Residential Sediment Control Devices
 FILE NAME: Stormwater 1b
 DATE: 11/19/08
 DRAWN BY: MB
 APPROVED BY: JMB




Scale: 1"=40'

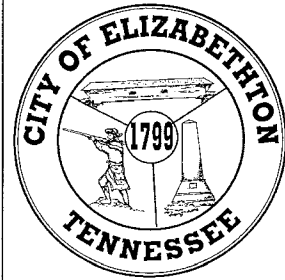


Top View of Curb, Grate Inlet
and Sediment Control Device

1"=1'

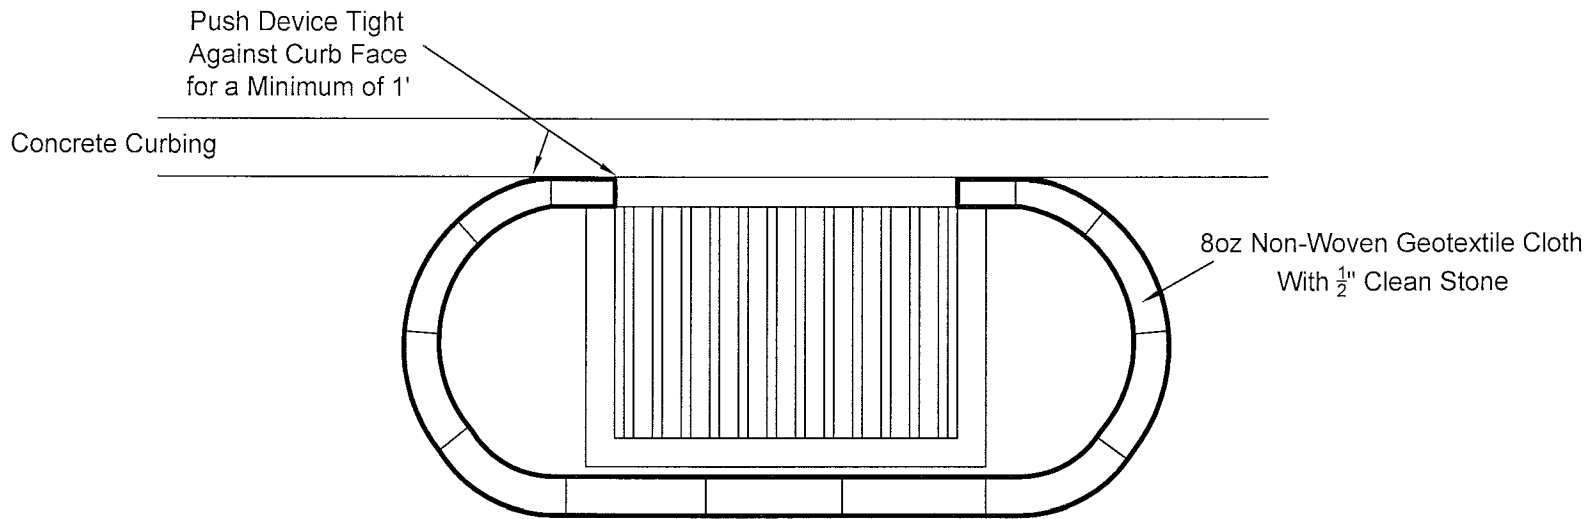

Section-View of Geotextile
Sediment Control Device

Not to Scale

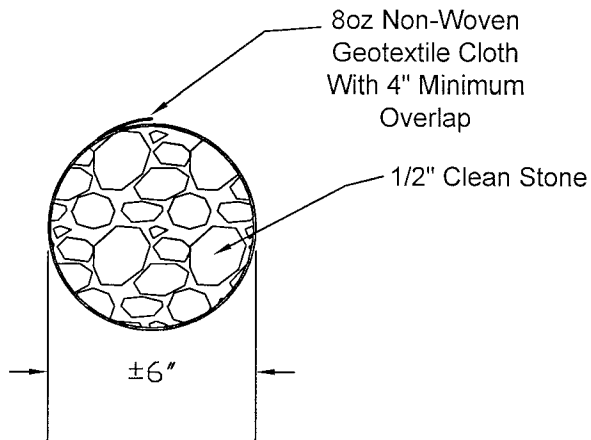

Cable Ties @ 1' Apart

NOTE: The captured sediment must be promptly removed once it becomes deeper than 1" at any given point. The device shall be maintained by the contractor who installed it.

Stormwater Sediment
Control Device for Grate
Inlets

BY	DATE	DESCRIPTION

PROJECT: Proposed 2" Waterline Earl McKinney
FILE NAME: Water deptic
DATE: 10/18/08
DRAWN BY: MB
APPROVED BY: MP



1"=1'

SHEET 1